



DEPARTMENT OF REGULATORY AND ECONOMIC RESOURCES (RER)
BOARD AND CODE ADMINISTRATION DIVISION

NOTICE OF ACCEPTANCE (NOA)

MIAMI-DADE COUNTY
PRODUCT CONTROL SECTION

11805 SW 26 Street, Room 208
T (786) 315-2590 F (786) 315-2599

www.miamidade.gov/economy

HWD Acquisition, Inc. dba Hurd Windows & Doors
575 South Whelen Avenue
Medford, WI 54451

SCOPE:

This NOA is being issued under the applicable rules and regulations governing the use of construction materials. The documentation submitted has been reviewed and accepted by Miami-Dade County RER - Product Control Section to be used in Miami Dade County and other areas where allowed by the Authority Having Jurisdiction (AHJ).

This NOA shall not be valid after the expiration date stated below. The Miami-Dade County Product Control Section (In Miami Dade County) and/or the AHJ (in areas other than Miami Dade County) reserve the right to have this product or material tested for quality assurance purposes. If this product or material fails to perform in the accepted manner, the manufacturer will incur the expense of such testing and the AHJ may immediately revoke, modify, or suspend the use of such product or material within their jurisdiction. RER reserves the right to revoke this acceptance, if it is determined by Miami-Dade County Product Control Section that this product or material fails to meet the requirements of the applicable building code.

This product is approved as described herein, and has been designed to comply with the Florida Building Code, including the High Velocity Hurricane Zone.

DESCRIPTION: Series "Feel Safe" Aluminum Clad Wood Awning Window - L.M.I.

APPROVAL DOCUMENT: Drawing No. 1405, titled "Feel Safe Aluminum Clad Wood Impact Awning Window, sheets 1 through 5 of 5, dated 07/21/05, with revision D1 dated 12/18/14, prepared by W. W. Schaefer Engineering & Consulting, P.A., signed and sealed by Warren W. Schaefer, P.E., bearing the Miami-Dade County Product Control Revision stamp with the Notice of Acceptance number and expiration date by the Miami-Dade County Product Control Section.

MISSILE IMPACT RATING: Large and Small Missile Impact Resistant

LABELING: Each unit shall bear a permanent label with the manufacturer's name or logo, city, state, model/series, and following statement: "Miami-Dade County Product Control Approved", unless otherwise noted herein.

RENEWAL of this NOA shall be considered after a renewal application has been filed and there has been no change in the applicable building code negatively affecting the performance of this product.

TERMINATION of this NOA will occur after the expiration date or if there has been a revision or change in the materials, use, and/or manufacture of the product or process. Misuse of this NOA as an endorsement of any product, for sales, advertising or any other purposes shall automatically terminate this NOA. Failure to comply with any section of this NOA shall be cause for termination and removal of NOA.

ADVERTISEMENT: The NOA number preceded by the words Miami-Dade County, Florida, and followed by the expiration date may be displayed in advertising literature. If any portion of the NOA is displayed, then it shall be done in its entirety.

INSPECTION: A copy of this entire NOA shall be provided to the user by the manufacturer or its distributors and shall be available for inspection at the job site at the request of the Building Official.

This NOA revises NOA# 11-1006.07 and consists of this page 1 and evidence pages E-1 and E-2, as well as approval document mentioned above.

The submitted documentation was reviewed by Manuel Perez, P.E.



Handwritten signature and date:
7/3/25/15

NOA No. 14-1224.06
Expiration Date: June 29, 2016
Approval Date: April 02, 2015
Page 1


NOTICE OF ACCEPTANCE: EVIDENCE SUBMITTED

A. DRAWINGS

1. Manufacturer's die drawings and sections.
2. Drawing No **1405**, titled "Feel Safe Aluminum Clad Wood Impact Awning Window, Sheets 1 through 5 of 5, dated 7/21/05, with revision D1 dated 12/18/14, prepared by W. W. Schaefer Engineering & Consulting, P.A., signed and sealed by Warren W. Schaefer, P.E.

B. TESTS

1. Test reports on: 1) Air Infiltration Test, per FBC, TAS 202-94
2) Uniform Static Air Pressure Test, Loading per FBC TAS 202-94
3) Water Resistance Test, per FBC, TAS 202-94
4) Large Missile Impact Test per FBC, TAS 201-94
5) Cyclic Wind Pressure Loading per FBC, TAS 203-94
6) Forced Entry Test, per FBC 2411 3.2.1, TAS 202-94
along with marked-up drawings and installation diagram of 6 specimens each consisting of aluminum clad casement window, prepared by Stork Twin City Testing Corporation, Test Report No. **STCTC-180-7795.2**, dated 04/08/09, signed and sealed by Thomas Allan Kolden, P.E.
(Submitted under NOA No. 09-0901.05)
2. Test reports on: 1) Air Infiltration Test, per FBC, TAS 202-94
2) Uniform Static Air Pressure Test, Loading per FBC, TAS 202-94
3) Water Resistance Test, per FBC, TAS 202-94
4) Large Missile Impact Test per FBC, TAS 201-94
5) Cyclic Wind Pressure Loading per FBC, TAS 203-94
6) Forced Entry Test, per FBC 2411 3.2.1 and TAS 202-94
along with marked-up drawings and installation diagram of 6 specimens each consisting of aluminum clad casement window, prepared by Architectural Testing, Inc., Test Report No. **ATI-52274.04-602-18**, dated 07/07-28/04, signed and sealed by Joseph A. Reed, P.E.
(Submitted under NOA No. 06-0130.05)


Manuel Perez, P.E.
Product Control Examiner
NOA No. 14-1224.06
Expiration Date: June 29, 2016
Approval Date: April 02, 2015

HWD Acquisition, Inc. dba Hurd Windows & Doors

NOTICE OF ACCEPTANCE: EVIDENCE SUBMITTED

B. TESTS (CONTINUED)

3. Test reports on: 1) Air Infiltration Test, per FBC, TAS 202-94
2) Uniform Static Air Pressure Test, Loading per FBC, TAS 202-94
3) Water Resistance Test, per FBC, TAS 202-94
4) Large Missile Impact Test per FBC, TAS 201-94
5) Cyclic Wind Pressure Loading per FBC, TAS 203-94
6) Forced Entry Test, per FBC 2411 3.2.1 and TAS 202-94
along with marked-up drawings and installation diagram of 6 specimens each
consisting of aluminum clad awning window, prepared by Architectural Testing, Inc.,
Test Report No. **ATI-53394.03-602-18**, dated 09/14-6/04, signed and sealed by Joseph
A. Reed, P.E.
(Submitted under NOA No. 06-0130.05)

C. CALCULATIONS:

1. Anchor Calculations and structural analysis, complying with the FBC-2007 and the
FBC-2010, prepared by W. W. Schaefer Engineering & Consulting, P.A., dated
05/12/11 and 10/04/11, signed and sealed by Warren W. Schaefer, P.E.
(Submitted under previous NOA #11-1006.07)
2. Glazing complies with ASTM E1300-04

D. QUALITY ASSURANCE

1. Miami-Dade Department of Regulatory and Economic Resources (RER).

E. MATERIAL CERTIFICATIONS


1. Notice of Acceptance No. **14-0423.17** issued to **Eastman Chemical Company (MA)**
for their "**Saflex Clear and Color Glass Interlayers**" dated 06/19/14, expiring on
05/21/16.


F. STATEMENTS

1. Statement letter of conformance, complying with **FBC-2010** and **FBC-5th Edition (2014)**, dated December 18, 2014, issued by W. W. Schaefer Engineering & Consulting, P.A., signed and sealed by Warren W. Schaefer, P.E.
2. Statement letter of no financial interest, dated December 18, 2014, issued by W. W. Schaefer Engineering & Consulting, P.A., signed and sealed by Warren W. Schaefer, P.E.

G. OTHERS

1. Notice of Acceptance No. **11-1006.07**, issued to HWD Acquisition, Inc. dba Hurd Windows & Doors for their Series "**Feel Safe**" Aluminum Clad Wood Awning Window L.M.I., approved on 11/07/11 and expiring on 06/29/16.

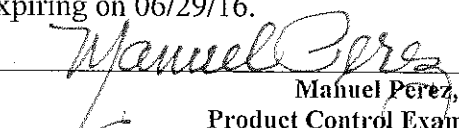
Manuel Perez, P.E.
Product Control Examiner
NOA No. 14-1224.06
Expiration Date: June 29, 2016
Approval Date: April 02, 2015

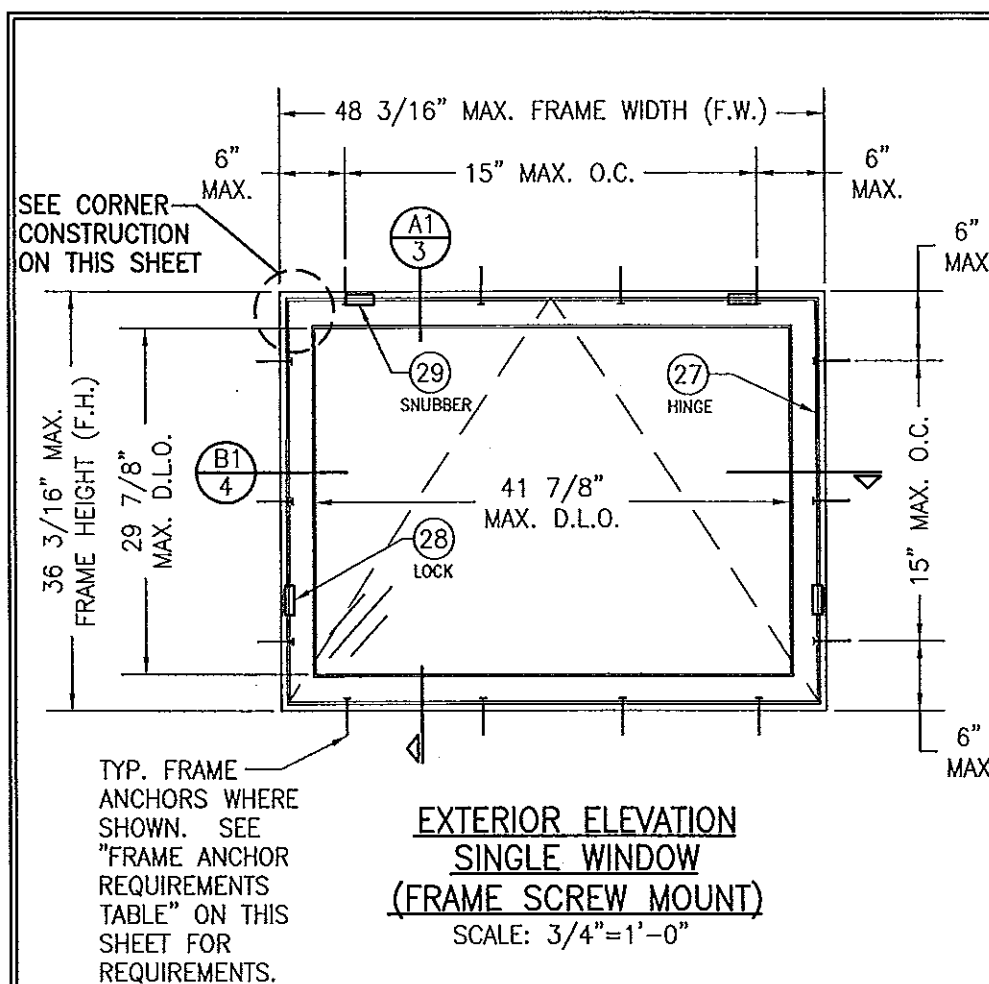

**EXTERIOR ELEVATION
SINGLE WINDOW
(FRAME SCREW MOUNT)**
SCALE: 3/4"=1'-0"

CORNER CONSTRUCTION:

WOOD FRAME: SQUARE CUT, RABBETED, SILICONE SEALED & SECURED WITH THREE (3) 16 GA. X 1/2" X 2" CROWN STAPLES.

FRAME CLAD: MITER CUT, JOINED WITH A CORNER KEY & TWO (2) NO. 7 X 1/2" SCREWS & SEALED WITH A FOAM GASKET.

WOOD SASH: MORTISE & TENON CONSTRUCTION AND SECURED WITH TWO (2) 14 GA. X 2 1/2" T-NAILS.

SASH CLAD: SQUARE CUT, BUTTED TOGETHER AND SNAP FIT TO SASH AND SEALED WITH SILICONE.


**ALLOWABLE DESIGN PRESSURE
(SINGLE & MULTIPLE WINDOWS)**

+65/-70 PSF

LOCK & SNUBBER REQUIREMENTS

SNUBBERS: ONE (1) EACH SIDE OF WINDOW AT THE HEAD OF THE FRAME, 6 1/2" OFF CORNERS.

LOCKS: ONE (1) LOCK STRIKE EACH SIDE OF WINDOW AT SIDES.

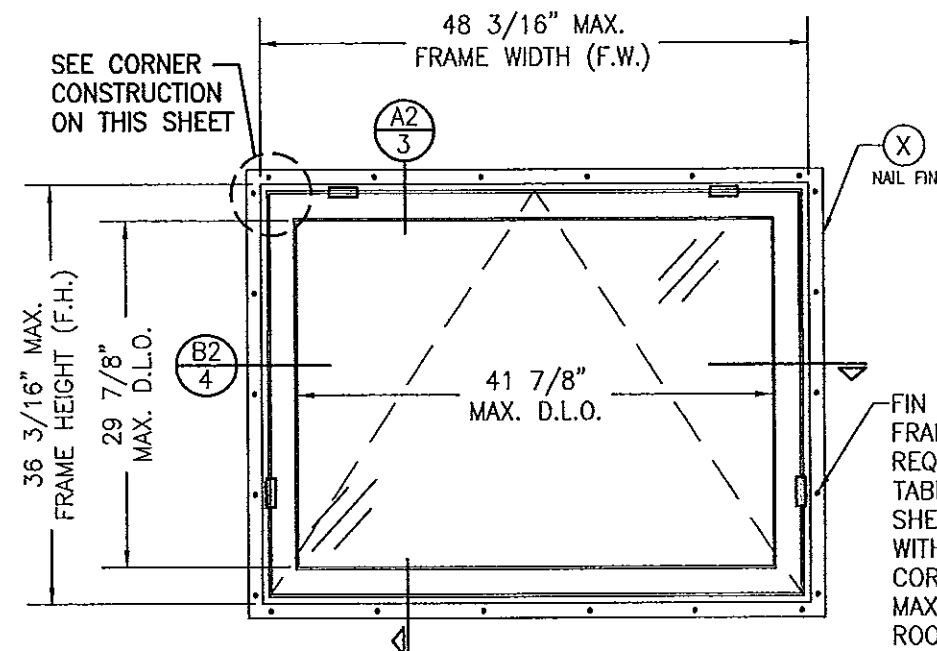

**EXTERIOR ELEVATION
SINGLE WINDOW
(FIN MOUNT)**
SCALE: 3/4"=1'-0"

FOR INFORMATION NOT SHOWN, SEE FRAME SCREW MOUNTED SINGLE WINDOW ELEVATION

FRAME ANCHOR REQUIREMENTS TABLE

OPENING TYPE (SUBSTRATE)	FRAME/FIN TO OPENING FASTENER TYPE	MINIMUM EMBED	MINIMUM EDGE DIST.
FRAME SCREWS			
MIN. 2X4 WOOD FRAME OR BUCK (MIN. GR. 3 & G=0.55)	NO. 10 SMS OR WOOD SCREW	1 1/4"	3/4"
MIN. 18 GA. 33 KSI METAL STUD	NO. 10 GR. 5 SELF TAP/DRILL SCREW	FULL	1/2"
MIN. 1/8" THK A36 STEEL	NO. 10 GR. 5 SELF TAP/DRILL SCREW	FULL	1/2"
MIN. 1/8" THK 6063-T5 ALUM.	NO. 10 GR. 5 SELF TAP/DRILL SCREW	FULL	1/2"
C-90 CMU/2500 PSI CONCRETE	(1) 1/4" CONCRETE SCREW	1 1/4"	2"
(2) NAILING FIN FASTENERS			
MIN. 2X4 WOOD FRAME OR BUCK (MIN. GR. 3 & G=0.55)	NO. 8 SMS SCREW	1 1/8"	1/2"
MIN. 2X4 WOOD FRAME OR BUCK (MIN. GR. 3 & G=0.55)	11 GA. ROOFING NAIL	1 3/4"	1/2"
MIN. 1/8" THK A36 STEEL	NO. 8 GR. 5 SELF TAP/DRILL SCREW	FULL	1/2"
MIN. 1/8" THK 6063-T5 ALUM.	NO. 8 GR. 5 SELF TAP/DRILL SCREW	FULL	1/2"


- (1) CONCRETE SCREWS SHALL BE ELCO ULTRACONS (C.S.), ELCO CRETE-FLEX (S.S.), ITW RAMSET/RED HEAD TAPCONS (C.S. OR S.S.) OR HILTI KWIK-CON II (C.S. OR S.S.).
- (2) NAIL FIN SCREWS SHALL BE A PAN HEAD OR HEX HEAD SCREW OR HAVE A FLAT WASHER AT THE SCREW HEAD.

GENERAL NOTES:

- THIS PRODUCT HAS BEEN TESTED, ANALYZED & APPROVED FOR DESIGN PRESSURES NOT TO EXCEED THOSE SHOWN IN THE "ALLOWABLE DESIGN PRESSURE TABLE(S)".
- OPENINGS, BUCKING & BUCKING FASTENERS MUST BE PROPERLY DESIGNED & INSTALLED TO TRANSFER WIND LOADS TO THE STRUCTURE.
- ALL HARDWARE & FASTENERS SHALL BE IN ACCORDANCE WITH THESE DRAWINGS & SHALL NOT VARY UNLESS SPECIFICALLY MENTIONED ON THE DRAWINGS. SPECIFIED ANCHOR EMBED TO BASE MATERIAL SHALL BE BEYOND WALL FINISH OR STUCCO.
- THE DETAILS & SPECIFICATIONS SHOWN HEREIN REPRESENT THE PRODUCTS TESTED & PROPOSED FOR CONFORMANCE WITH THE FLORIDA BUILDING CODE PROTOCOLS TAS-201, 202 & 203 FOR LARGE MISSILE IMPACT PRODUCTS.
- THIS PRODUCT HAS BEEN DESIGNED IN ACCORDANCE WITH AND MEETS THE REQUIREMENTS OF THE FLORIDA BUILDING CODE (FBC) INCLUDING HIGH VELOCITY HURRICANE ZONES (HVHZ).
- IMPACT SHUTTERS ARE NOT REQUIRED WITH THIS PRODUCT.
- ALL ANCHORS SECURING PRODUCT FRAMES TO PRESSURE TREATED BUCKS OR WOOD FRAMING SHALL BE CAPABLE OF RESISTING CORROSION CAUSED BY THE PRESSURE TREATING CHEMICALS IN THE WOOD.
- DETERMINE THE POSITIVE & NEGATIVE DESIGN LOADS TO USE WHEN REFERENCING THESE DOCUMENTS IN ACCORDANCE WITH THE GOVERNING CODE AND GOVERNING WIND VELOCITY. FOR WIND LOAD CALCULATIONS IN ACCORDANCE WITH THE FLORIDA BUILDING CODE, A DIRECTIONALITY FACTOR OF $K_d = 0.85$ MAY BE APPLIED PER THE ASCE-7 STANDARD.
- NO INCREASE IN ALLOWABLE STRESS HAS BEEN USED IN THE CERTIFICATION OF THIS PRODUCT. WIND LOAD DURATION FACTOR $C_d = 1.6$ WAS USED FOR WOOD SCREW ANALYSIS ONLY.
- MATERIALS, INCLUDING BUT NOT LIMITED TO STEEL SCREWS, THAT COME INTO CONTACT WITH OTHER DISSIMILAR MATERIALS SHALL MEET THE REQUIREMENTS OF FLORIDA BUILDING CODE.
- ALL WOOD MEMBERS OF THIS PRODUCT THAT MAY POSSIBLY COME INTO CONTACT WITH MASONRY OR CONCRETE SUBSTRATES, ARE SUBJECT TO MOISTURE &/OR ARE SUBJECT TO THE OUTSIDE ENVIRONMENT SHALL BE OF AN APPROVED DURABLE SPECIES OR BE TREATED IN AN APPROVED METHOD WITH AN APPROVED PRESERVATIVE PER FBC REQUIREMENTS.

PRODUCT REVISED
as complying with the Florida
Building Code
Acceptance No. 14-1224-06
Expiration Date June 29, 2016
By *Manuel Perez*
Miami Dade Product Control

DRAWN BY: S.T.R.		CHECKED BY: W.W.S.	
PLOT: 1=16		DATE: 7/21/05	
DATE	BY	REVISION	DESCRIPTION
08/24/09	W.W.S.	A1	ADD I.G. GLAZING CONDITION
06/29/11	WRM	B1	CHANGE MANUFACTURER NAME
10/04/11	WRM	C1	UPDATE CONSULTANT ADDRESS
12/18/14	W.W.S.	D1	UPDATE TO CURRENT STANDARDS
DRAWING TITLE FEEL SAFE ALUMINUM CLAD WOOD IMPACT AWNING WINDOW			
MANUFACTURER HWD ACQUISITION, INC. dba HURD WINDOWS & DOORS 575 S. WHELEN AVE. MEDFORD, WI 54451 800-433-4873		CONSULTANTS W. W. SCHAEFER ENGINEERING & CONSULTING, P.A. (CA 6809) 7480 150TH COURT NORTH PALM BEACH GARDENS, FL 33418 PHONE: 561-744-3424	
CERTIFICATION DEC 18 2014 WARREN W. SCHAEFER, P.E. P.E. NO. 44135		DRAWING NO. 1405 REV. D SHEET NO. 1 OF 5	

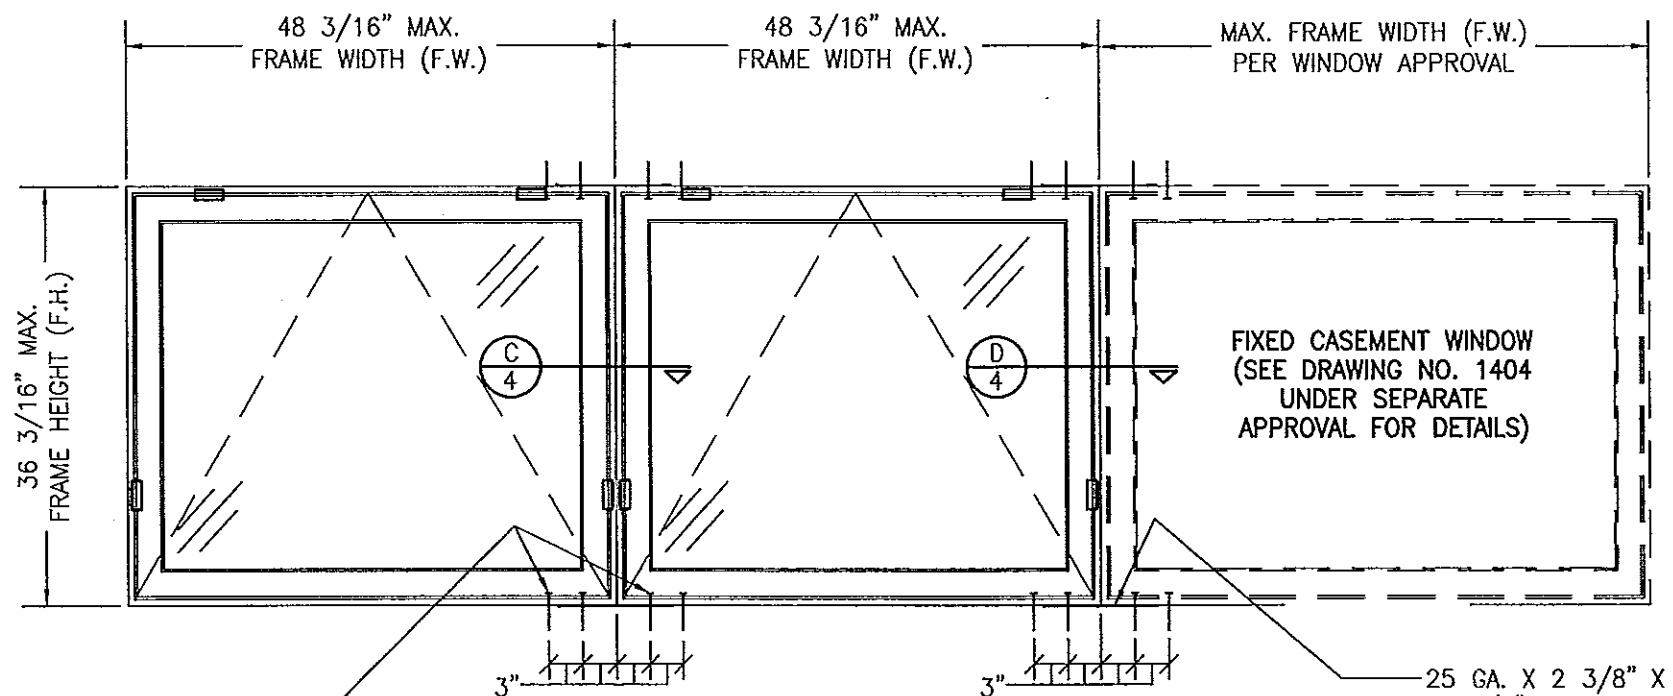


NO. 10 SCREWS PER
FRAME ANCHOR
REQUIREMENTS TABLE.
FOUR (4) TOTAL PER
MULLION END WHETHER
WINDOW IS SCREW
MOUNTED OR FIN
MOUNTED.

**EXTERIOR ELEVATION
MULTIPLE OPERABLE/FIXED WINDOWS STACKED HORIZONTAL**

SCALE: 3/4"=1'-0"
(FOR INDIVIDUAL WINDOW INSTALLATION & DETAILS, SEE SINGLE WINDOW ELEVATIONS)
(TRIPLE WINDOW SHOWN. MORE THAN 3 WINDOWS MAY BE COMBINED
HORIZONTALLY IN ONE OPENING IN ANY COMBINATION OF FIXED & OPERABLE)
NOTE: FOR FIXED TO FIXED, SEE DRAWING 1404 UNDER SEPARATE APPROVAL

FOR INFORMATION NOT SHOWN, SEE SINGLE
WINDOW ELEVATIONS ON SHEET 1

25 GA. X 2 3/8" X
10 1/4" GALVANIZED
MULLION END
REINFORCEMENT
PLATE STAPLED TO
EACH JAMB WITH
FIVE (5) 16 GA. X
7/16" X 9/16"
LONG STAPLES. (TYP.
EACH END OF EACH
MULLION)

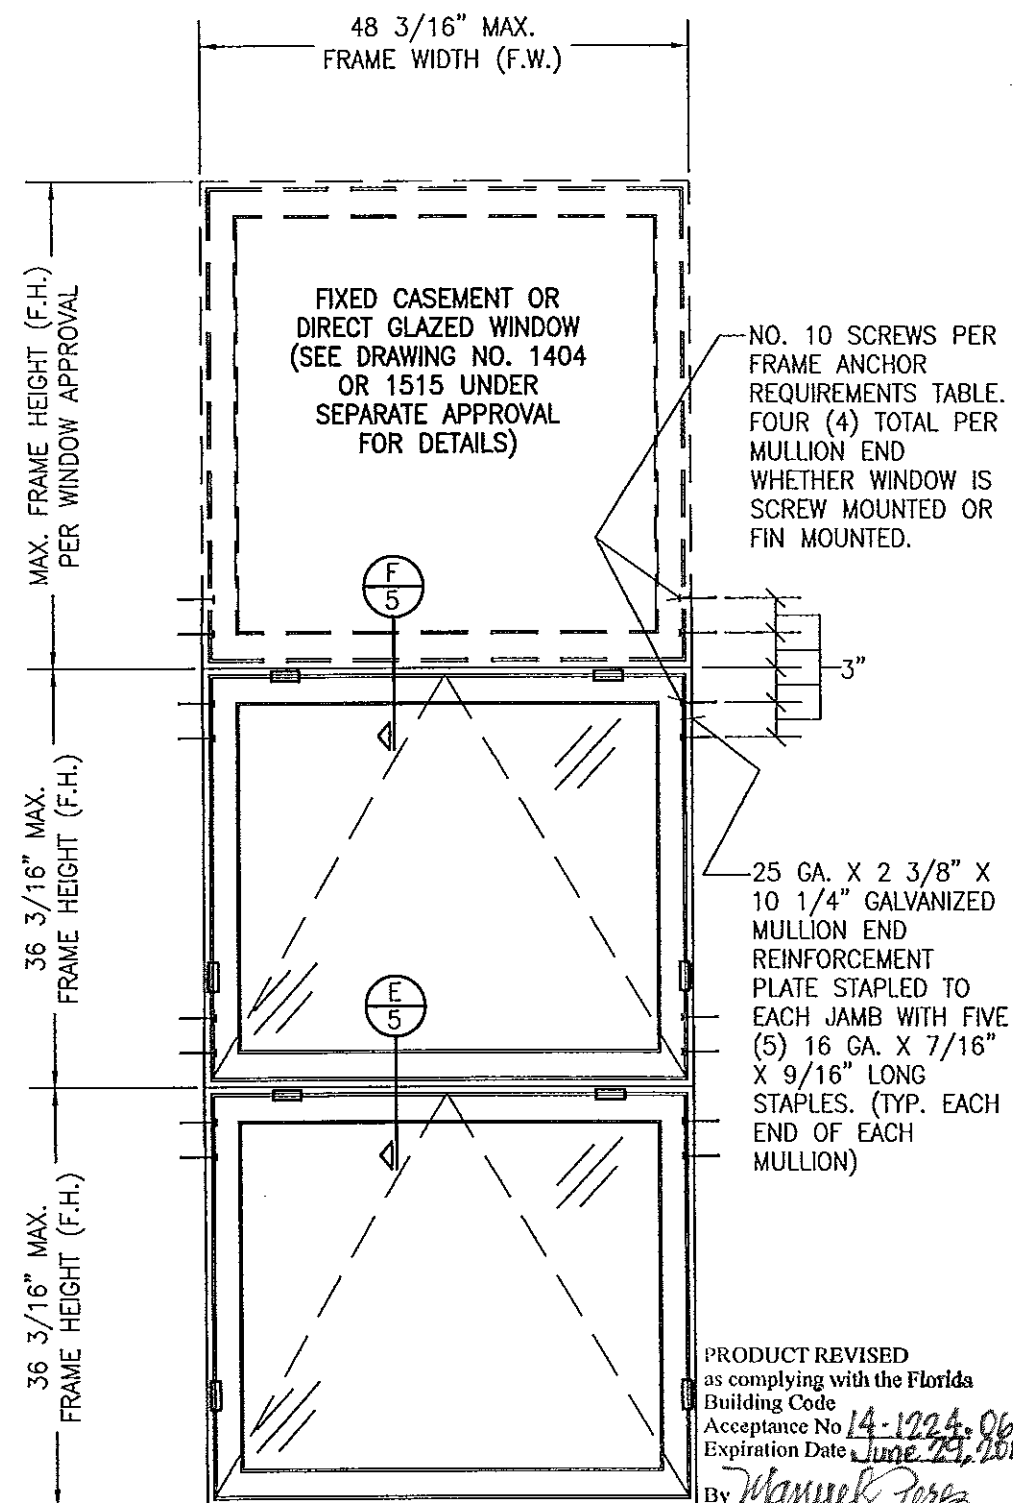

NO. 10 SCREWS PER
FRAME ANCHOR
REQUIREMENTS TABLE.
FOUR (4) TOTAL PER
MULLION END
WHETHER WINDOW IS
SCREW MOUNTED OR
FIN MOUNTED.

25 GA. X 2 3/8" X
10 1/4" GALVANIZED
MULLION END
REINFORCEMENT
PLATE STAPLED TO
EACH JAMB WITH FIVE
(5) 16 GA. X 7/16"
X 9/16" LONG
STAPLES. (TYP. EACH
END OF EACH
MULLION)

PRODUCT REVISED
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Acceptance No. 14-1224-06
Expiration Date June 29, 2016
By *Mmanuel Perez*
Miami Dade Product Control

**EXTERIOR ELEVATION
MULTIPLE OPERABLE/FIXED WINDOWS
STACKED VERTICAL**

SCALE: 3/4"=1'-0"
(FOR INDIVIDUAL WINDOW INSTALLATION & DETAILS, SEE SINGLE WINDOW ELEVATIONS)
(TRIPLE WINDOW SHOWN. MORE THAN 3 WINDOWS MAY BE COMBINED
VERTICALLY IN ONE OPENING IN ANY COMBINATION OF FIXED & OPERABLE)

FOR INFORMATION NOT SHOWN, SEE SINGLE
WINDOW ELEVATIONS ON SHEET 1


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PLOT: 1=16		DATE: 7/21/05	
DATE	BY	REVISION DESCRIPTION	NO.
DRAWING TITLE FEEL SAFE ALUMINUM CLAD WOOD IMPACT AWNING WINDOW		MANUFACTURER HWD ACQUISITION, INC. dba HURD WINDOWS & DOORS 575 S. WHELEN AVE. MEDFORD, WI 54451 800-433-4873	
CONSULTANTS W. W. SCHAEFER ENGINEERING & CONSULTING, P.A. (CA 6809) 7480 150TH COURT NORTH PALM BEACH GARDENS, FL 33418 PHONE: 561-744-3424		CERTIFICATION DEC 18 2014 STATE OF FLORIDA WARREN W. SCHAEFER, P.E. P.E. NO. 44135	
DRAWING NO. 1405		REV. D	
SHEET NO. 2		OF 5	

MIN. 2X4 BUCK/FRAMING
& BUCK ATTACHMENT BY
OTHERS

FRAME ANCHOR
PER ELEVATION

1/4" MAX.
SHIM AT
EACH ANCHOR

SEALANT BY
OTHERS

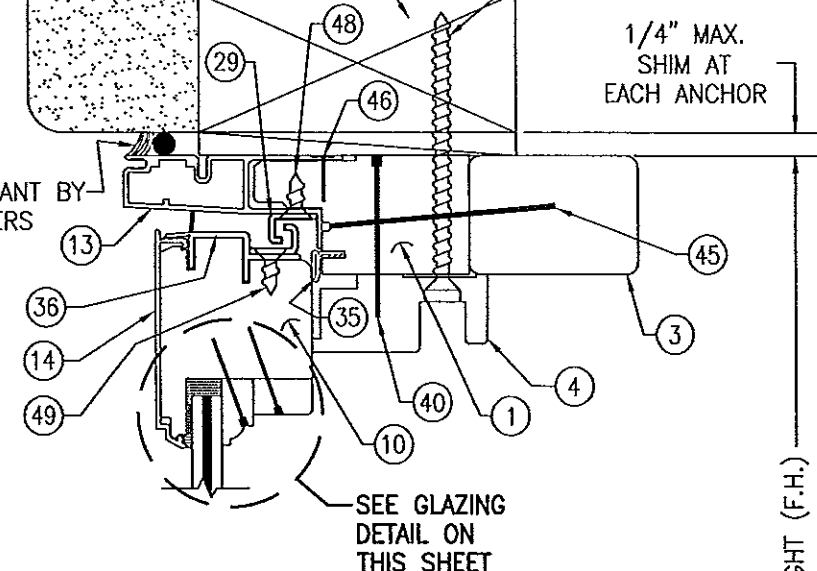

EXTERIOR

SEE GLAZING
DETAIL ON
THIS SHEET

FRAME HEIGHT (F.H.)


MIN. 2X4 BUCK/FRAMING
& BUCK ATTACHMENT BY
OTHERS

CONTINUOUS
SEALANT
BEHIND FIN
BY OTHERS

FIN FASTENERS
PER ELEVATION

3/8" MAX.
SPACE

SEALANT BY
OTHERS

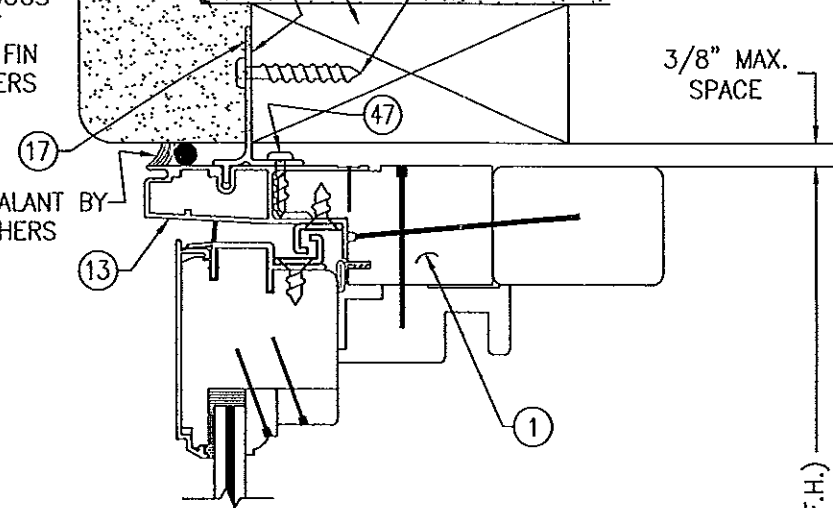

EXTERIOR

FRAME HEIGHT (F.H.)

5/16" LAMINATED GLASS
BY OLDCASTLE
(1/8" AN/0.09 EASTMAN CHEM.
CO. SAFLEX/1/8" AN)

SEE 2-PIECE
DETAIL BELOW
FOR INFORMATION
NOT SHOWN

1" BRAD NAILS 2"
FROM CORNERS &
8" TO 10" O.C.

GLAZING DETAIL WITH
1-PIECE GLAZING BEAD

TREMCO S900
SILICONE AT
EXTERIOR &
GLASS EDGE

1/16" SHIM AS
REQUIRED

1/8" THICK
SHIMS AS
REQUIRED

5/16" LAMINATED GLASS
BY OLDCASTLE
(1/8" AN/0.09 EASTMAN CHEM.
CO. SAFLEX/1/8" AN)

1" BRAD NAILS 2"
FROM CORNERS &
8" TO 10" O.C.

9/16" MIN. BITE

GLAZING DETAIL WITH
2-PIECE GLAZING BEAD

SEE I.G. GLASS
OPTION BELOW

TREMCO S900 SILICONE AT
EXTERIOR & GLASS EDGE

9/16" MIN. BITE

1/16" SHIM AS REQUIRED

1/8" THICK SHIMS
AS REQUIRED

1" BRAD NAILS 2"
FROM CORNERS &
8" TO 10" O.C.

TYPICAL I.G. GLAZING DETAIL

I.G. GLASS OPTION: 7/8" LAMINATED I.G. BY OLDCASTLE
(1/8" AN/0.09 EASTMAN CHEM. CO. SAFLEX/1/8" AN.
EXTERIOR; 7/16" SPACER; 1/8" TEMP. INTERIOR)

PRODUCT REVISED
as complying with the Florida
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Expiration Date June 29, 2016
By *Manuel Jara*
Miami/Dade Product Control

DRAWN BY: S.T.R.	CHECKED BY: W.W.S.
PLOT: 1=2	DATE: 7/21/05
DATE	BY
REVISION DESCRIPTION	NO.
FEEL SAFE ALUMINUM CLAD WOOD IMPACT AWNING WINDOW MANUFACTURER HWD ACQUISITION, INC. dba HURD WINDOWS & DOORS 575 S. WHELEN AVE. MEDFORD, WI 54451 800-433-4873	
CONSULTANTS W. W. SCHAEFER ENGINEERING & CONSULTING, P.A. (CA 6809) 7480 150TH COURT NORTH PALM BEACH GARDENS, FL 33418 PHONE: 561-744-3424	
CERTIFICATION DEC 18 2014 WARREN M. SCHAEFER P.E. P.E. NO. 44135	
DRAWING NO. 1405	REV. D
SHEET NO. 3 OF 5	



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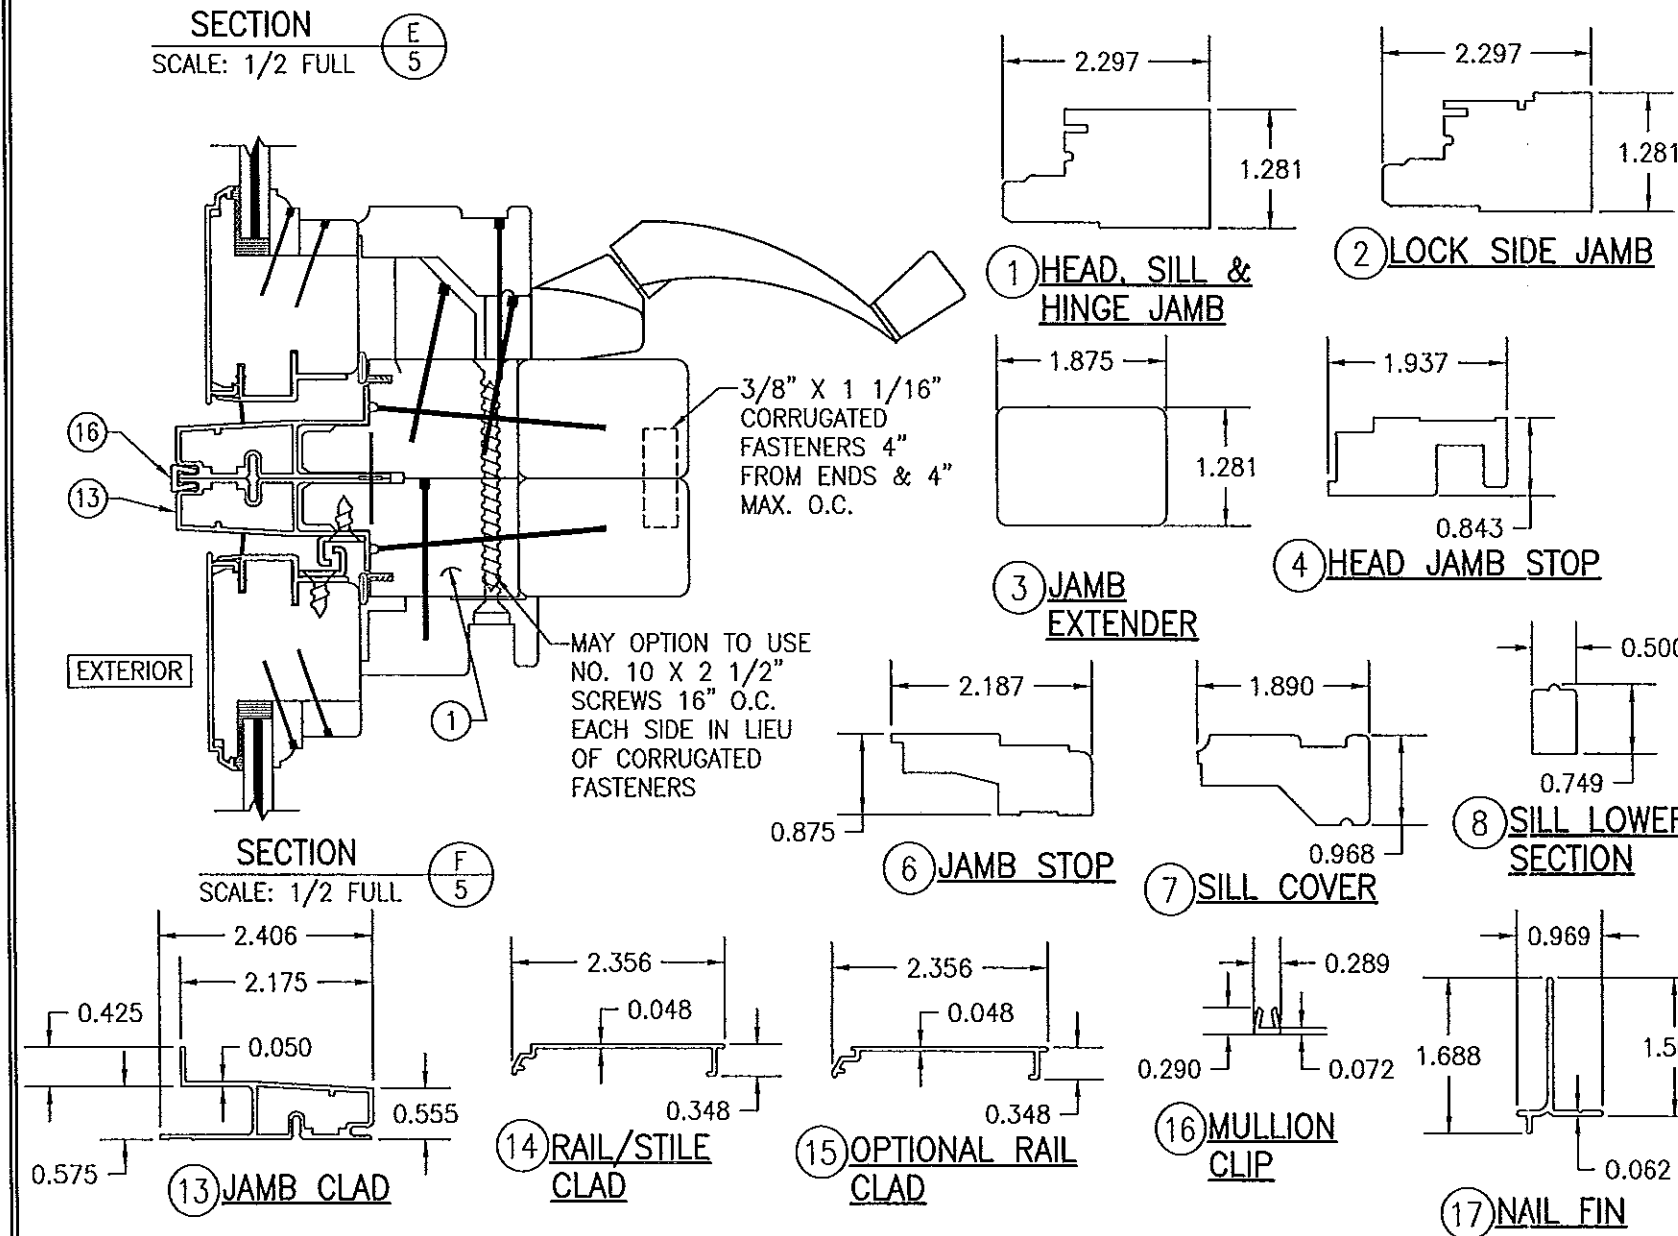
A1
3

SECTION
SCALE: 1/2 FULL


A2
3

(SEE SECTION A1/3 FOR DETAILS NOT SHOWN)

[illegible]

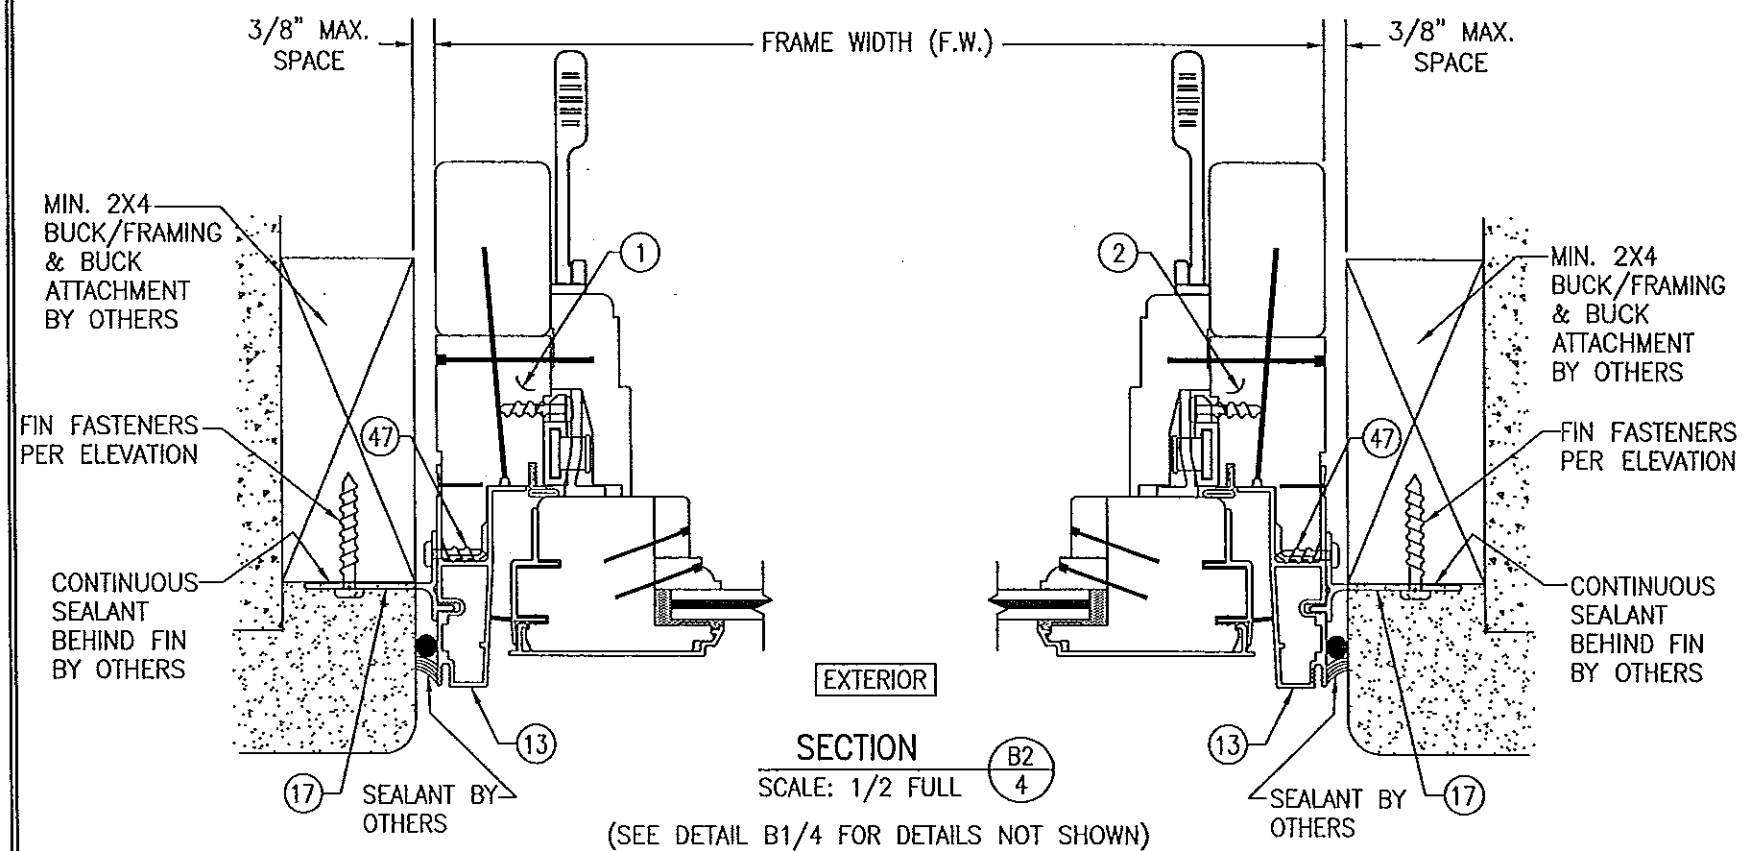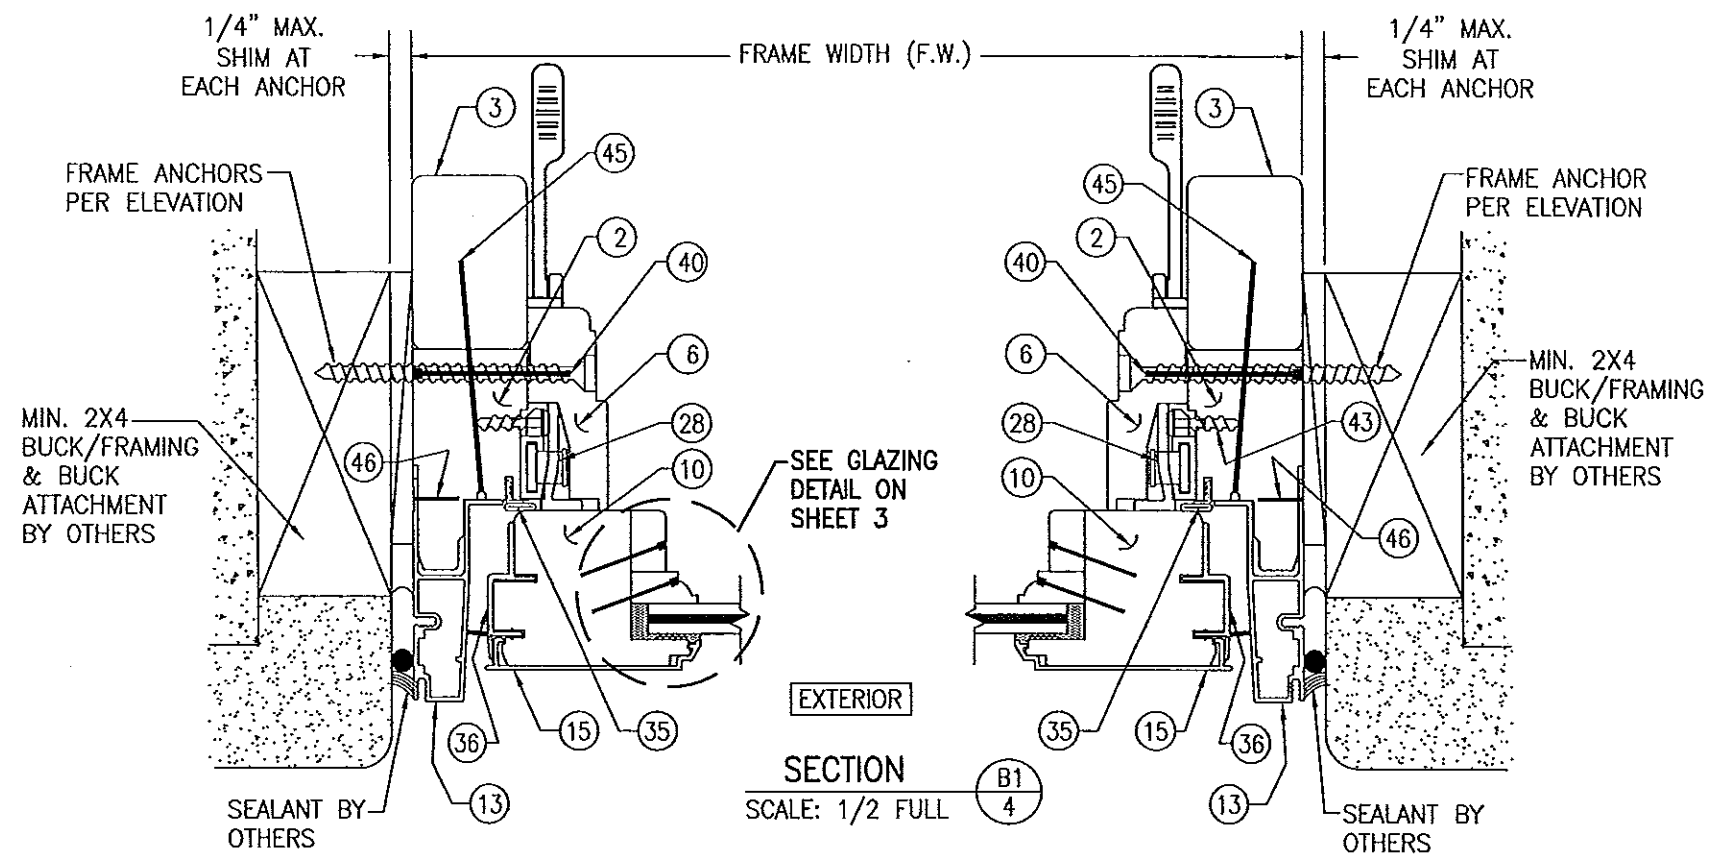

NOTE: WOOD USED IN TESTING WAS PONDEROSA PINE. OTHER WOOD SPECIES APPLICABLE FOR USE WITH THIS PRODUCT ARE THOSE WITH A SPECIFIC GRAVITY OF 0.43 AND MODULUS OF ELASTICITY OF 1,200,000 PSI OR GREATER. ALL WOOD IS MINIMUM GRADE 2 MILLED BY HURD WINDOWS & DOORS TO SELECT.

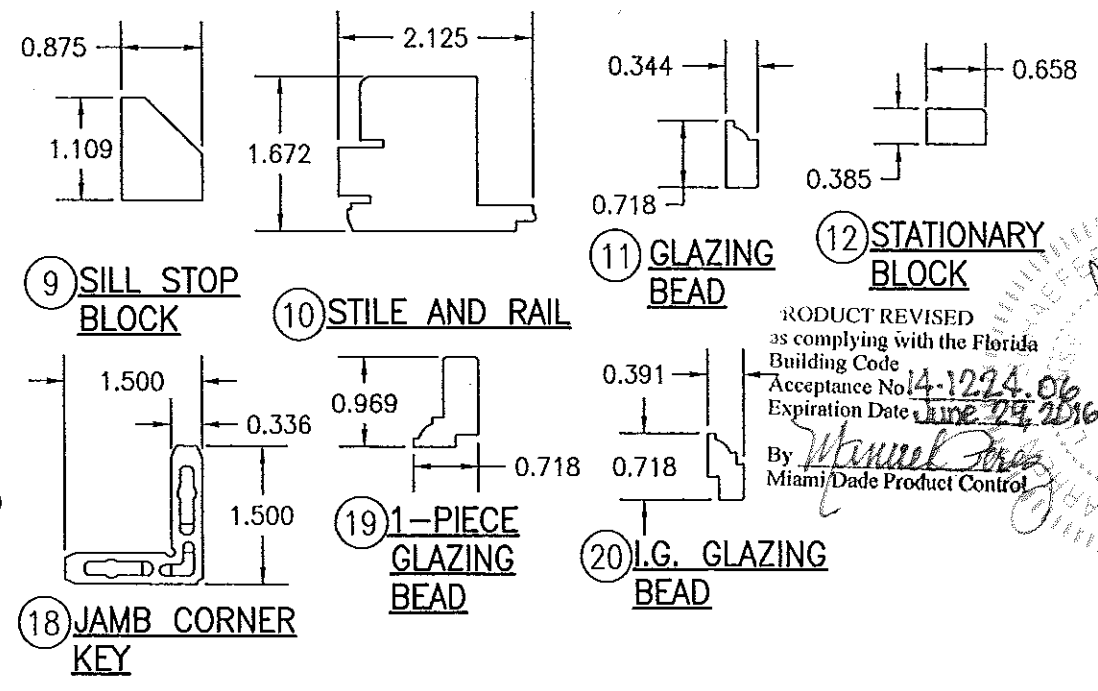

DRAWING NO.		REV.	
1405		D	
SHEET NO.			
<div style="display: flex; justify-content: space-between;"> 5 OF 5 </div>			
<div style="display: flex; justify-content: space-between;"> <div style="width: 45%;"> <p>CERTIFICATION</p> <p style="text-align: center; font-size: 1.5em; font-weight: bold;">DEC 18 2014</p> <p style="text-align: right;">WARREN W. SCHAEFER, P.E. P.E. NO. 44135</p> </div> <div style="width: 50%; text-align: center;"> <p><small>CONSULTANTS</small></p> <p>W. W. SCHAEFER ENGINEERING & CONSULTING, P.A. (CA 6809)</p> <p><small>7480 150TH COURT NORTH PALM BEACH GARDENS, FL 33418 PHONE: 561-744-3424</small></p> </div> </div>			
DRAWING TITLE		MANUFACTURER	
FEEL SAFE ALUMINUM CLAD WOOD IMPACT AWNING WINDOW		<p>HWD ACQUISITION, INC. dba HURD WINDOWS & DOORS 575 S. WHELEN AVE. MEDFORD, WI 54451 800-433-4873</p>	
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1405		D	
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<div style="display: flex; justify-content: space-between;"> 5 OF 5 </div>			
DRAWING TITLE		MANUFACTURER	
FEEL SAFE ALUMINUM CLAD WOOD IMPACT AWNING WINDOW		<p>HWD ACQUISITION, INC. dba HURD WINDOWS & DOORS 575 S. WHELEN AVE. MEDFORD, WI 54451 800-433-4873</p>	
DRAWING NO.		REV.	
1405		D	
SHEET NO.			
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DRAWING TITLE		MANUFACTURER	
FEEL SAFE ALUMINUM CLAD WOOD IMPACT AWNING WINDOW		<p>HWD ACQUIS</p>	